

FRONT ELEVATION SECTION A-A'

ARCHITECTURAL DRAWING

CONSTRUCTION AGENCY

- 1. ALL DIMENSIONS ARE IN MM.
- 2. ONLY FIGURED DIMENSIONS SHOULD BE FOLLOWED.
- 3. INNER WALLS- 115 MM
 OUTER WALLS- 230 MM

TOTAL NO. OF ROOMS- 48 NOS. (DOUBLE SEATER ROOM)

CAPACITY - 96 BEDDED

TOTAL PLINTH AREA-1525.6 SQ.M

PROJECT TITLE

IIIT- G BONGORA, GUWAHATI-15

DRAWING TITLE

BOYS HOSTEL ELEVATION & SECTION

DWG. No.

	AR-BH-03
DATE	JULY-2021
SCALE	NTS


SCALE N.T.S.


DRAWN BY AR.HANSHIKA


CHECKED BY AR.ROHIT

ARCHITECT


FOR TENDER PURPOSE ONLY

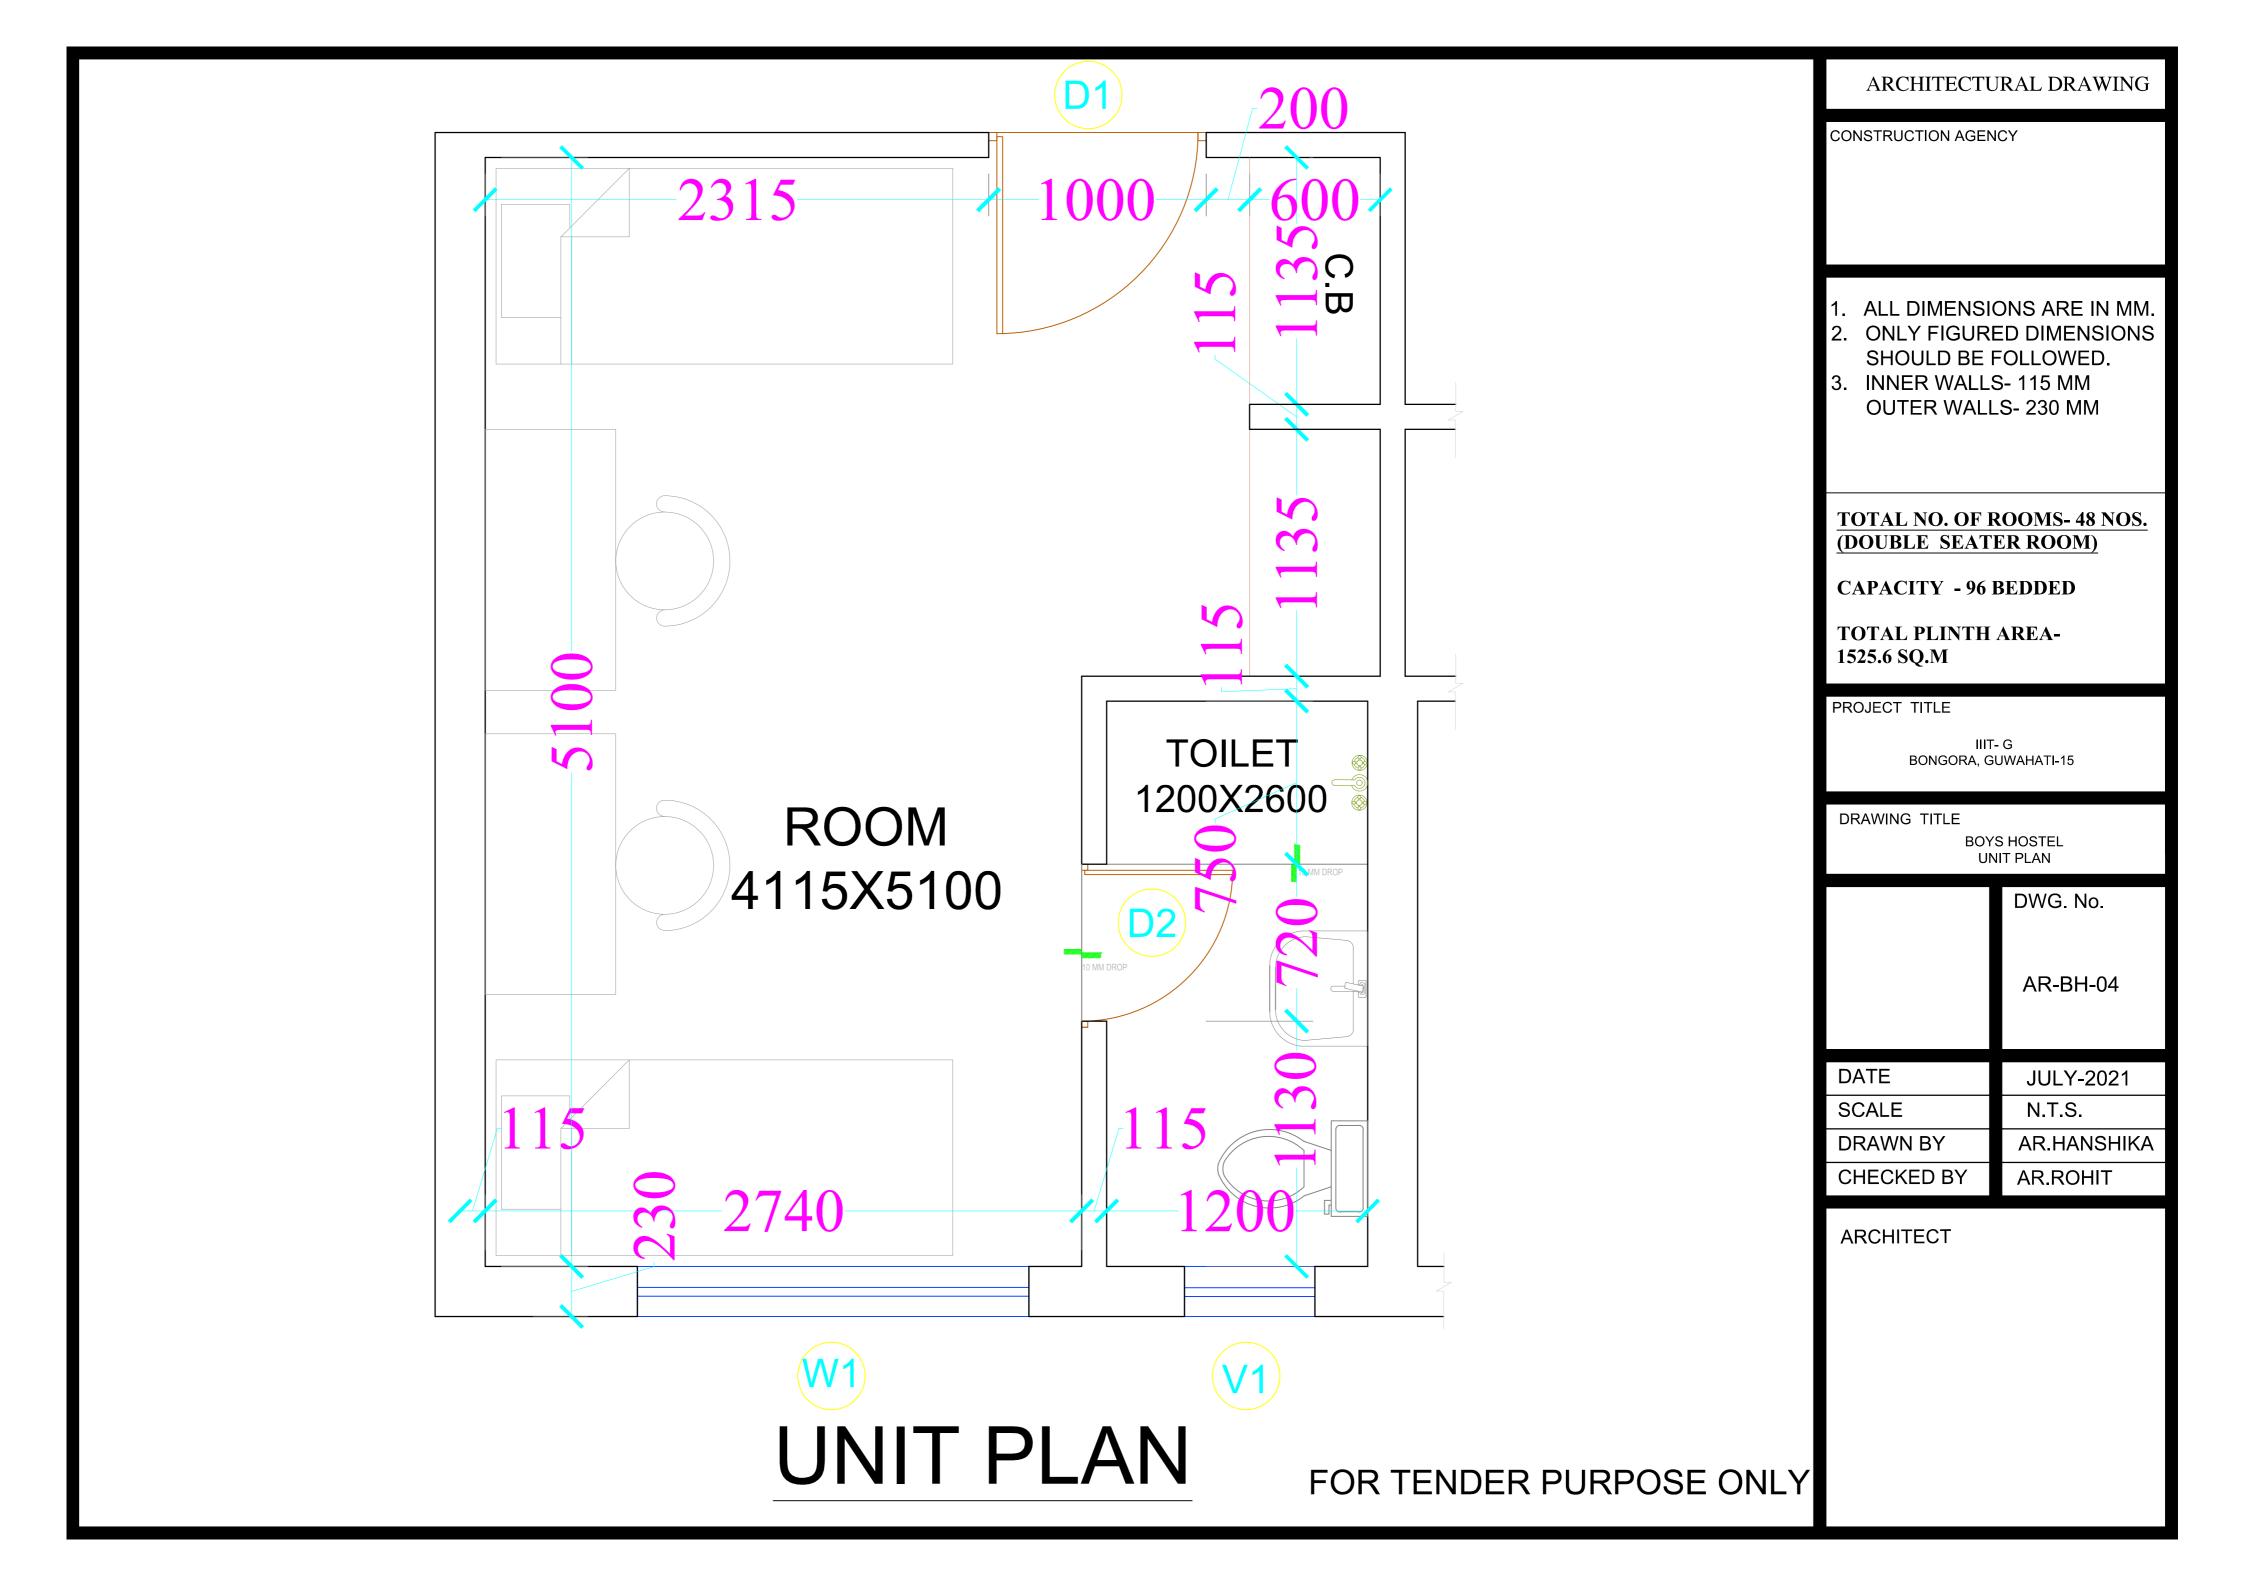


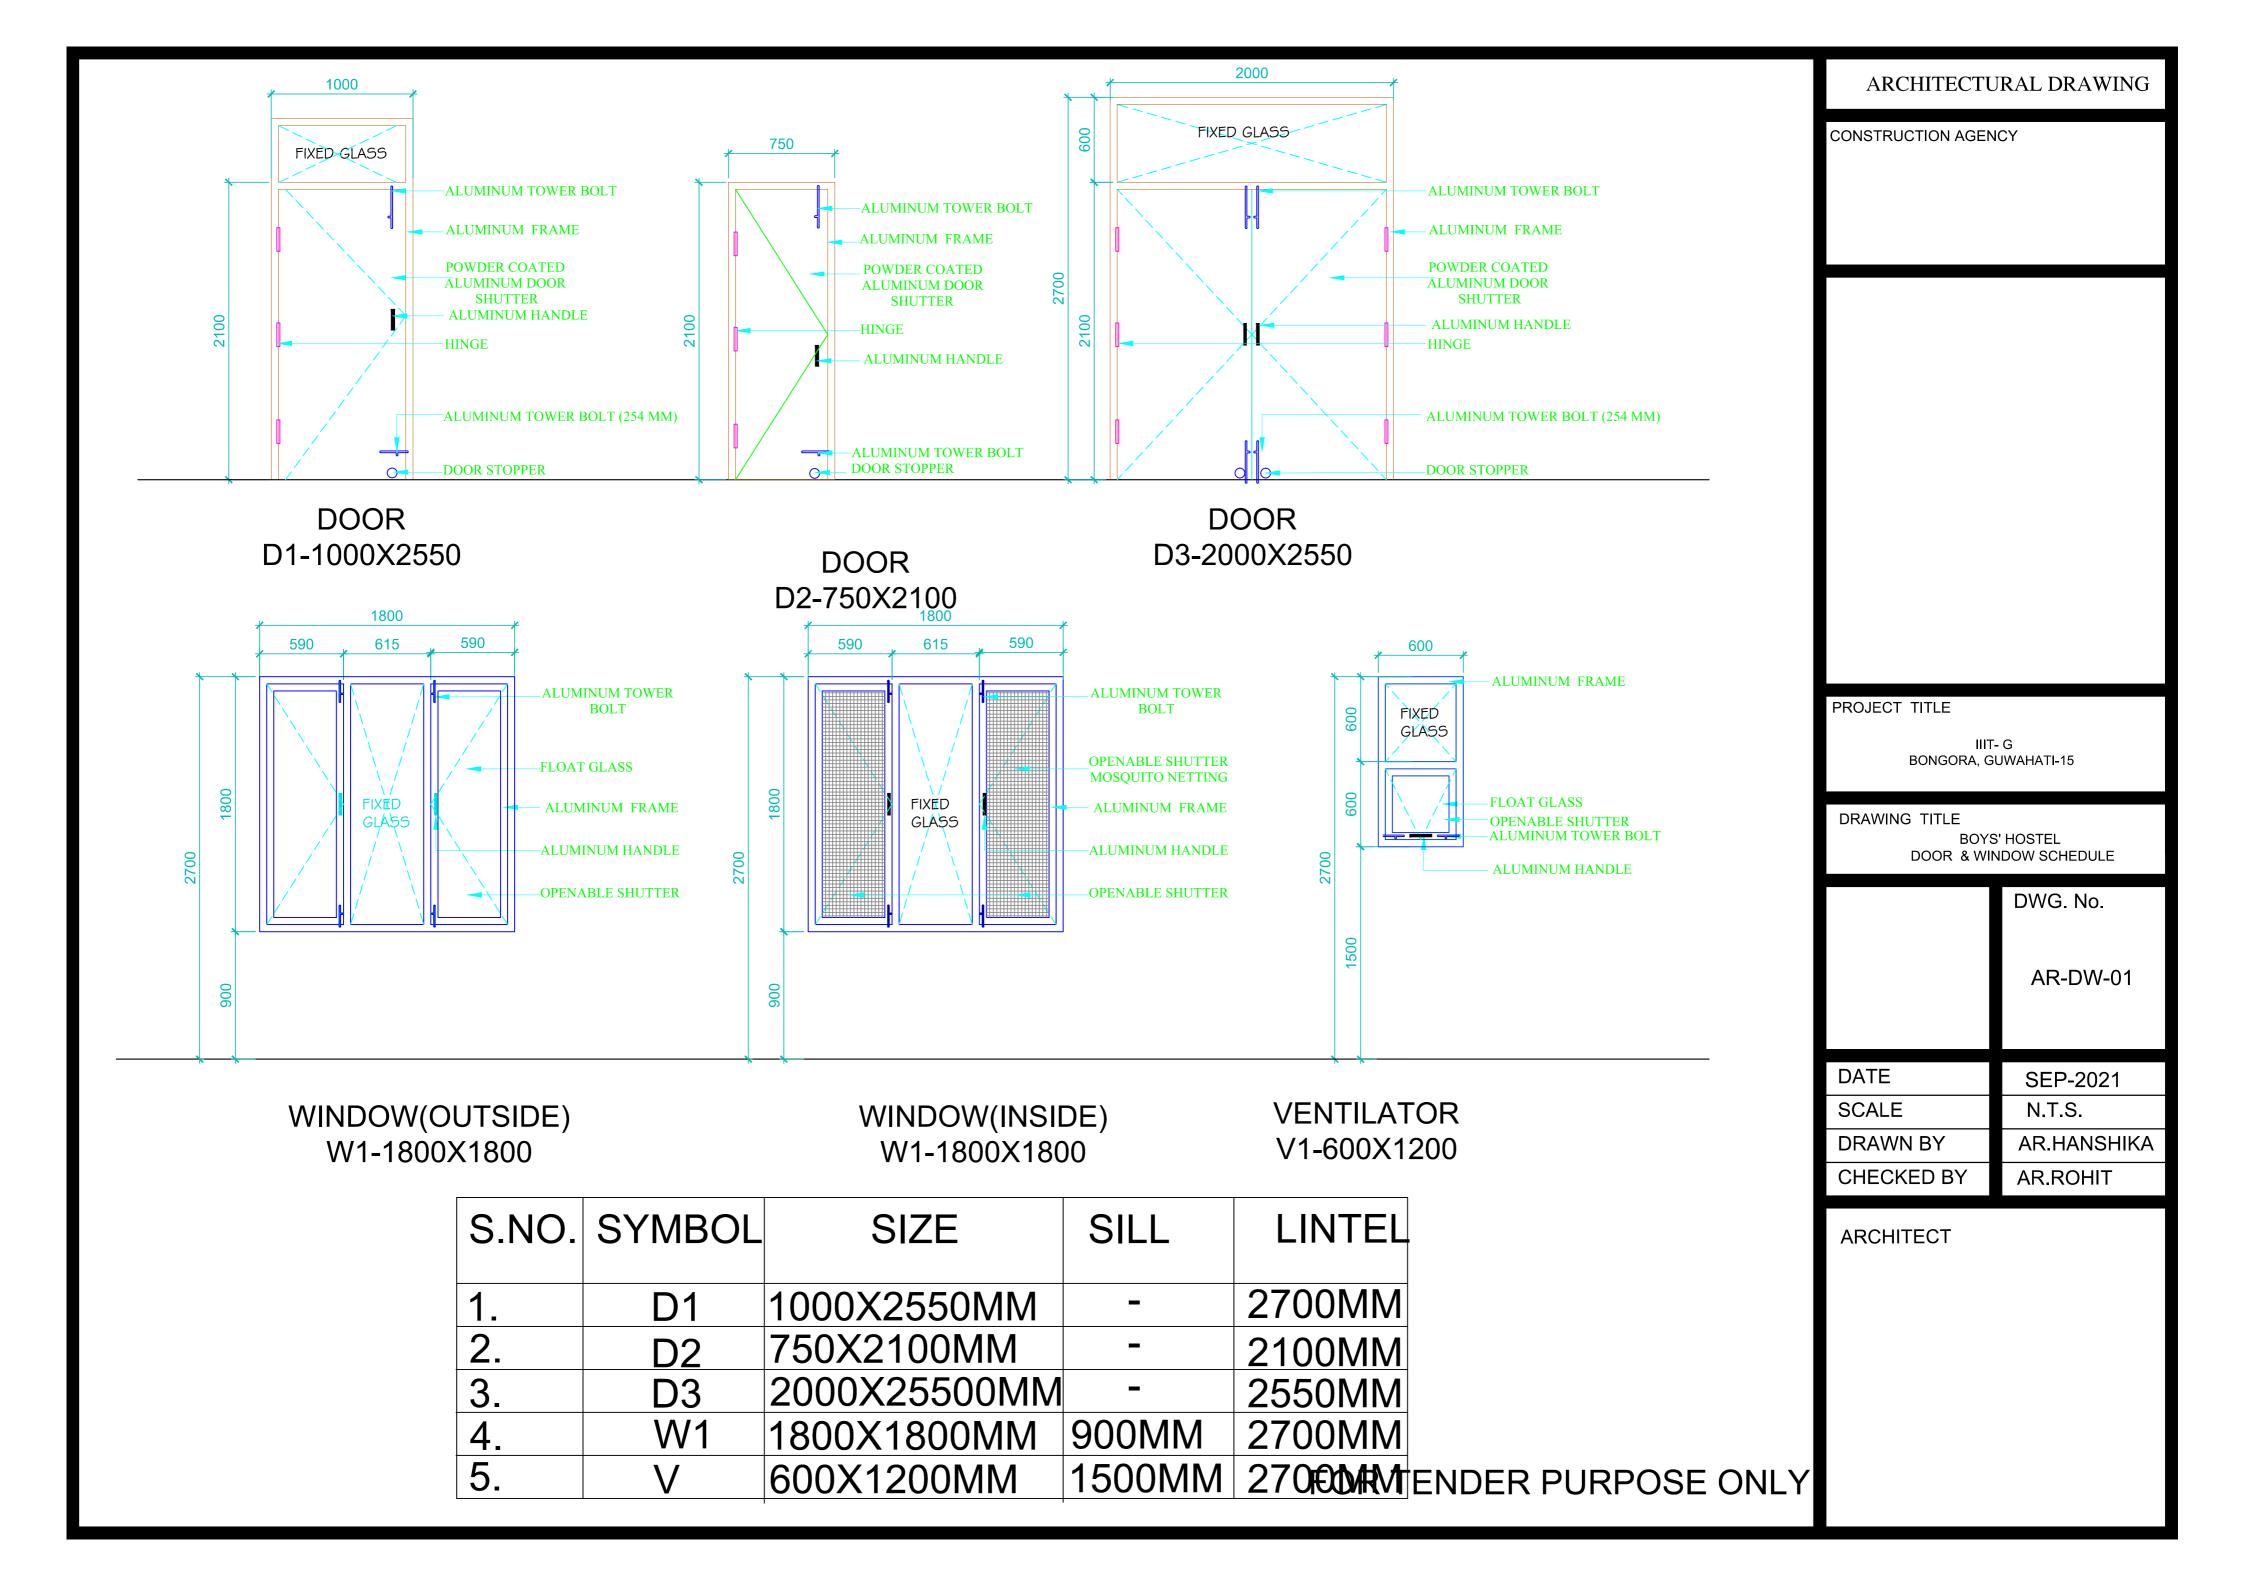


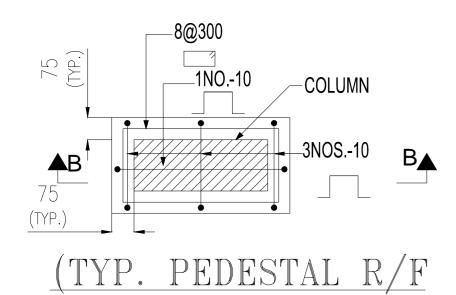


DETAIL FOR ALL COL.)

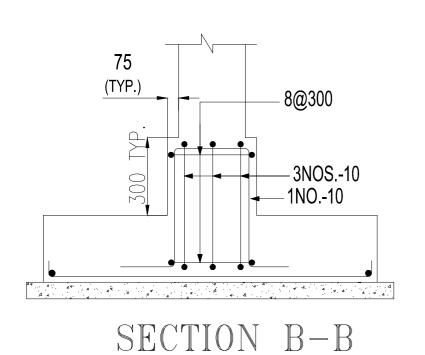

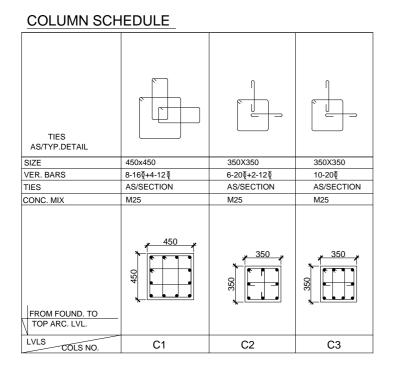

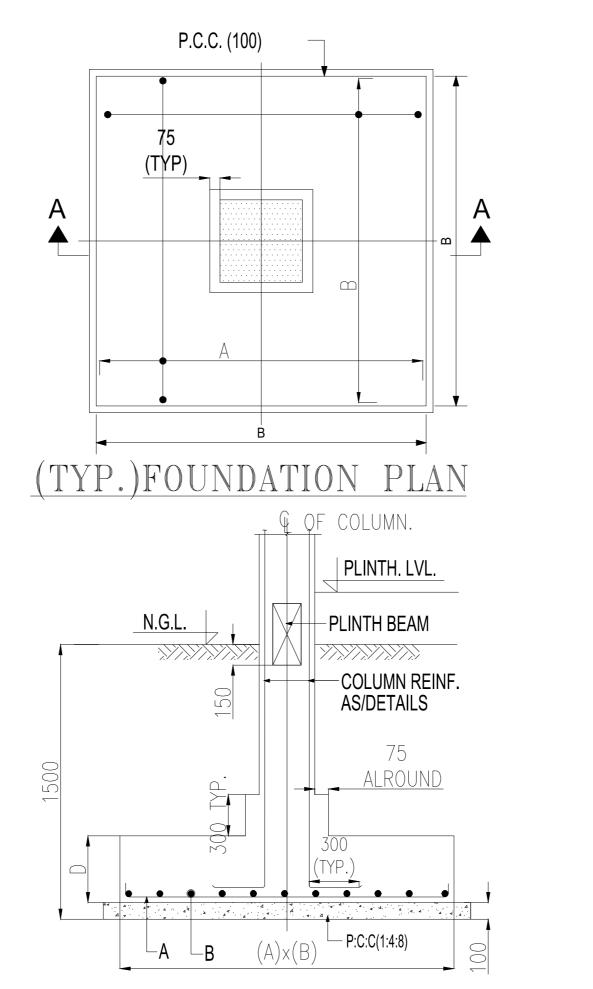

(TYP.)ISOLATED FOOTING DETAIL
SECTION A-A

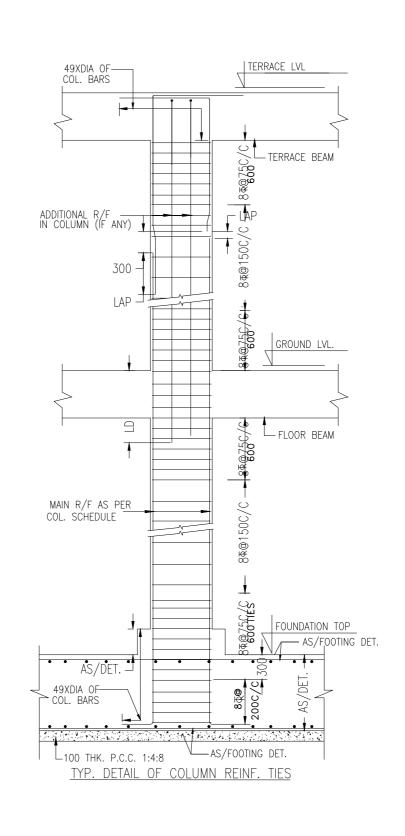

NOTES THIS DRG SHALL BE READ IN CONJUNCTION WITH RELEVANT ARCH. & SERVICES DRGS. THIS BLDG. IS DESIGNED FOR GROUND FLOOR ONLY. SAFE BEARING CAP. IS TAKEN AS 8.0 T/M AT 1.5M DEEP ALL LOOSE POCKETS FOUND IN EXCAVATION SHALL BE REPLACED BY LEAN CONC. (1:4:8). CONC. MIX M-25 FOR ALL RCC WORK U.N.O. CLEAR COVER TO OUTER BARS SHALL BE AS FOLLOW: FTG= 50, COLS.=40, BEAMS=25, SLABS = 20MM. LAP LENGTH FOR ALL BARS SHALL BE 49X DIA OF BARS 200TH. & 100MM TH. BLOCK WORK SHALL BE IN CEM. SAND 1:6 & 1:4 RESPECTIVELY. HIGH STRENGTH DEFORMED BARS OF YIELD STRENGTH 500 N/mm² SHALL BE USED AS REINF. FOR ALL RCC WORK.

10. FOR DESIGN PURPOSES SEISMIC ZONE-V AS PER IS1893
IS CONSIDERED. **ARCHITECTS:** CLIENT: IIIT- G BONGORA, GUWAHATI-15 STRUCTURAL CONSULTANT. PROJECT. BOYS HOSTEL IIIT- G

BONGORA, GUWAHATI-15

Drg. No.

STR-01

Checked

Revision

R0

FOUNDATION DETAILS


07.08.2021


rawn Dealt
PRAVEEN SANJAY


DRAWING TITLE


Job. No.


FOR TENDER PURPOSE ONLY

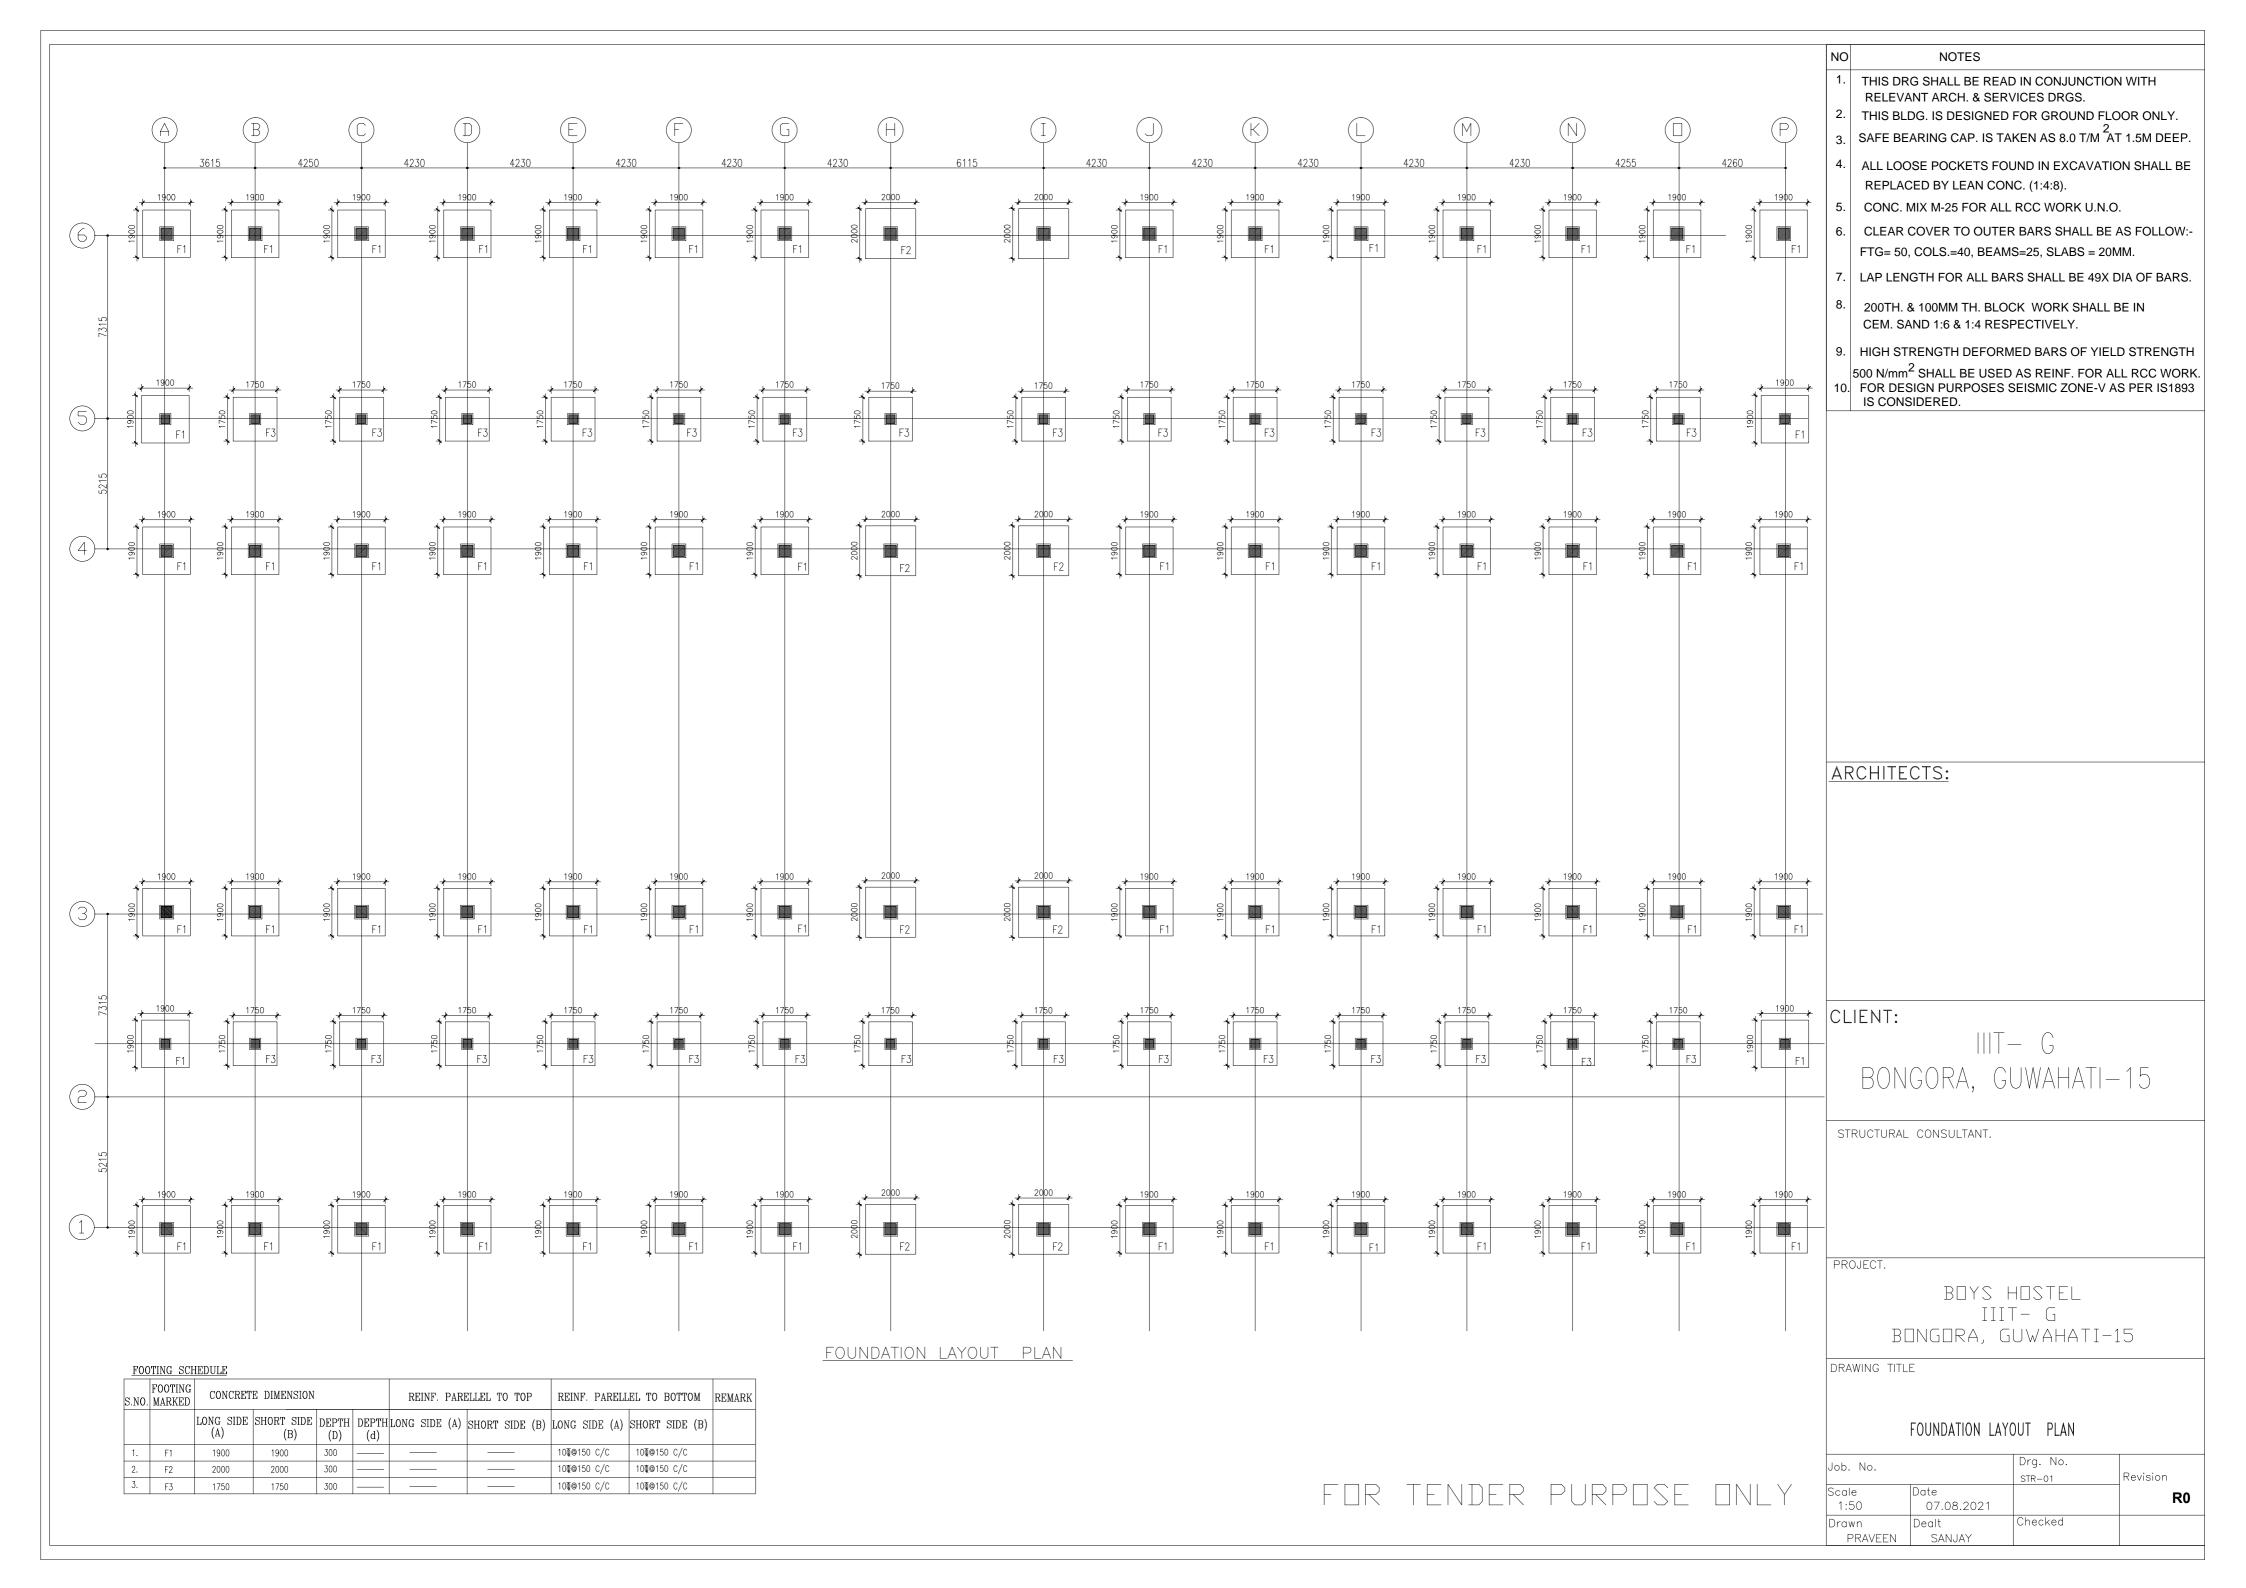


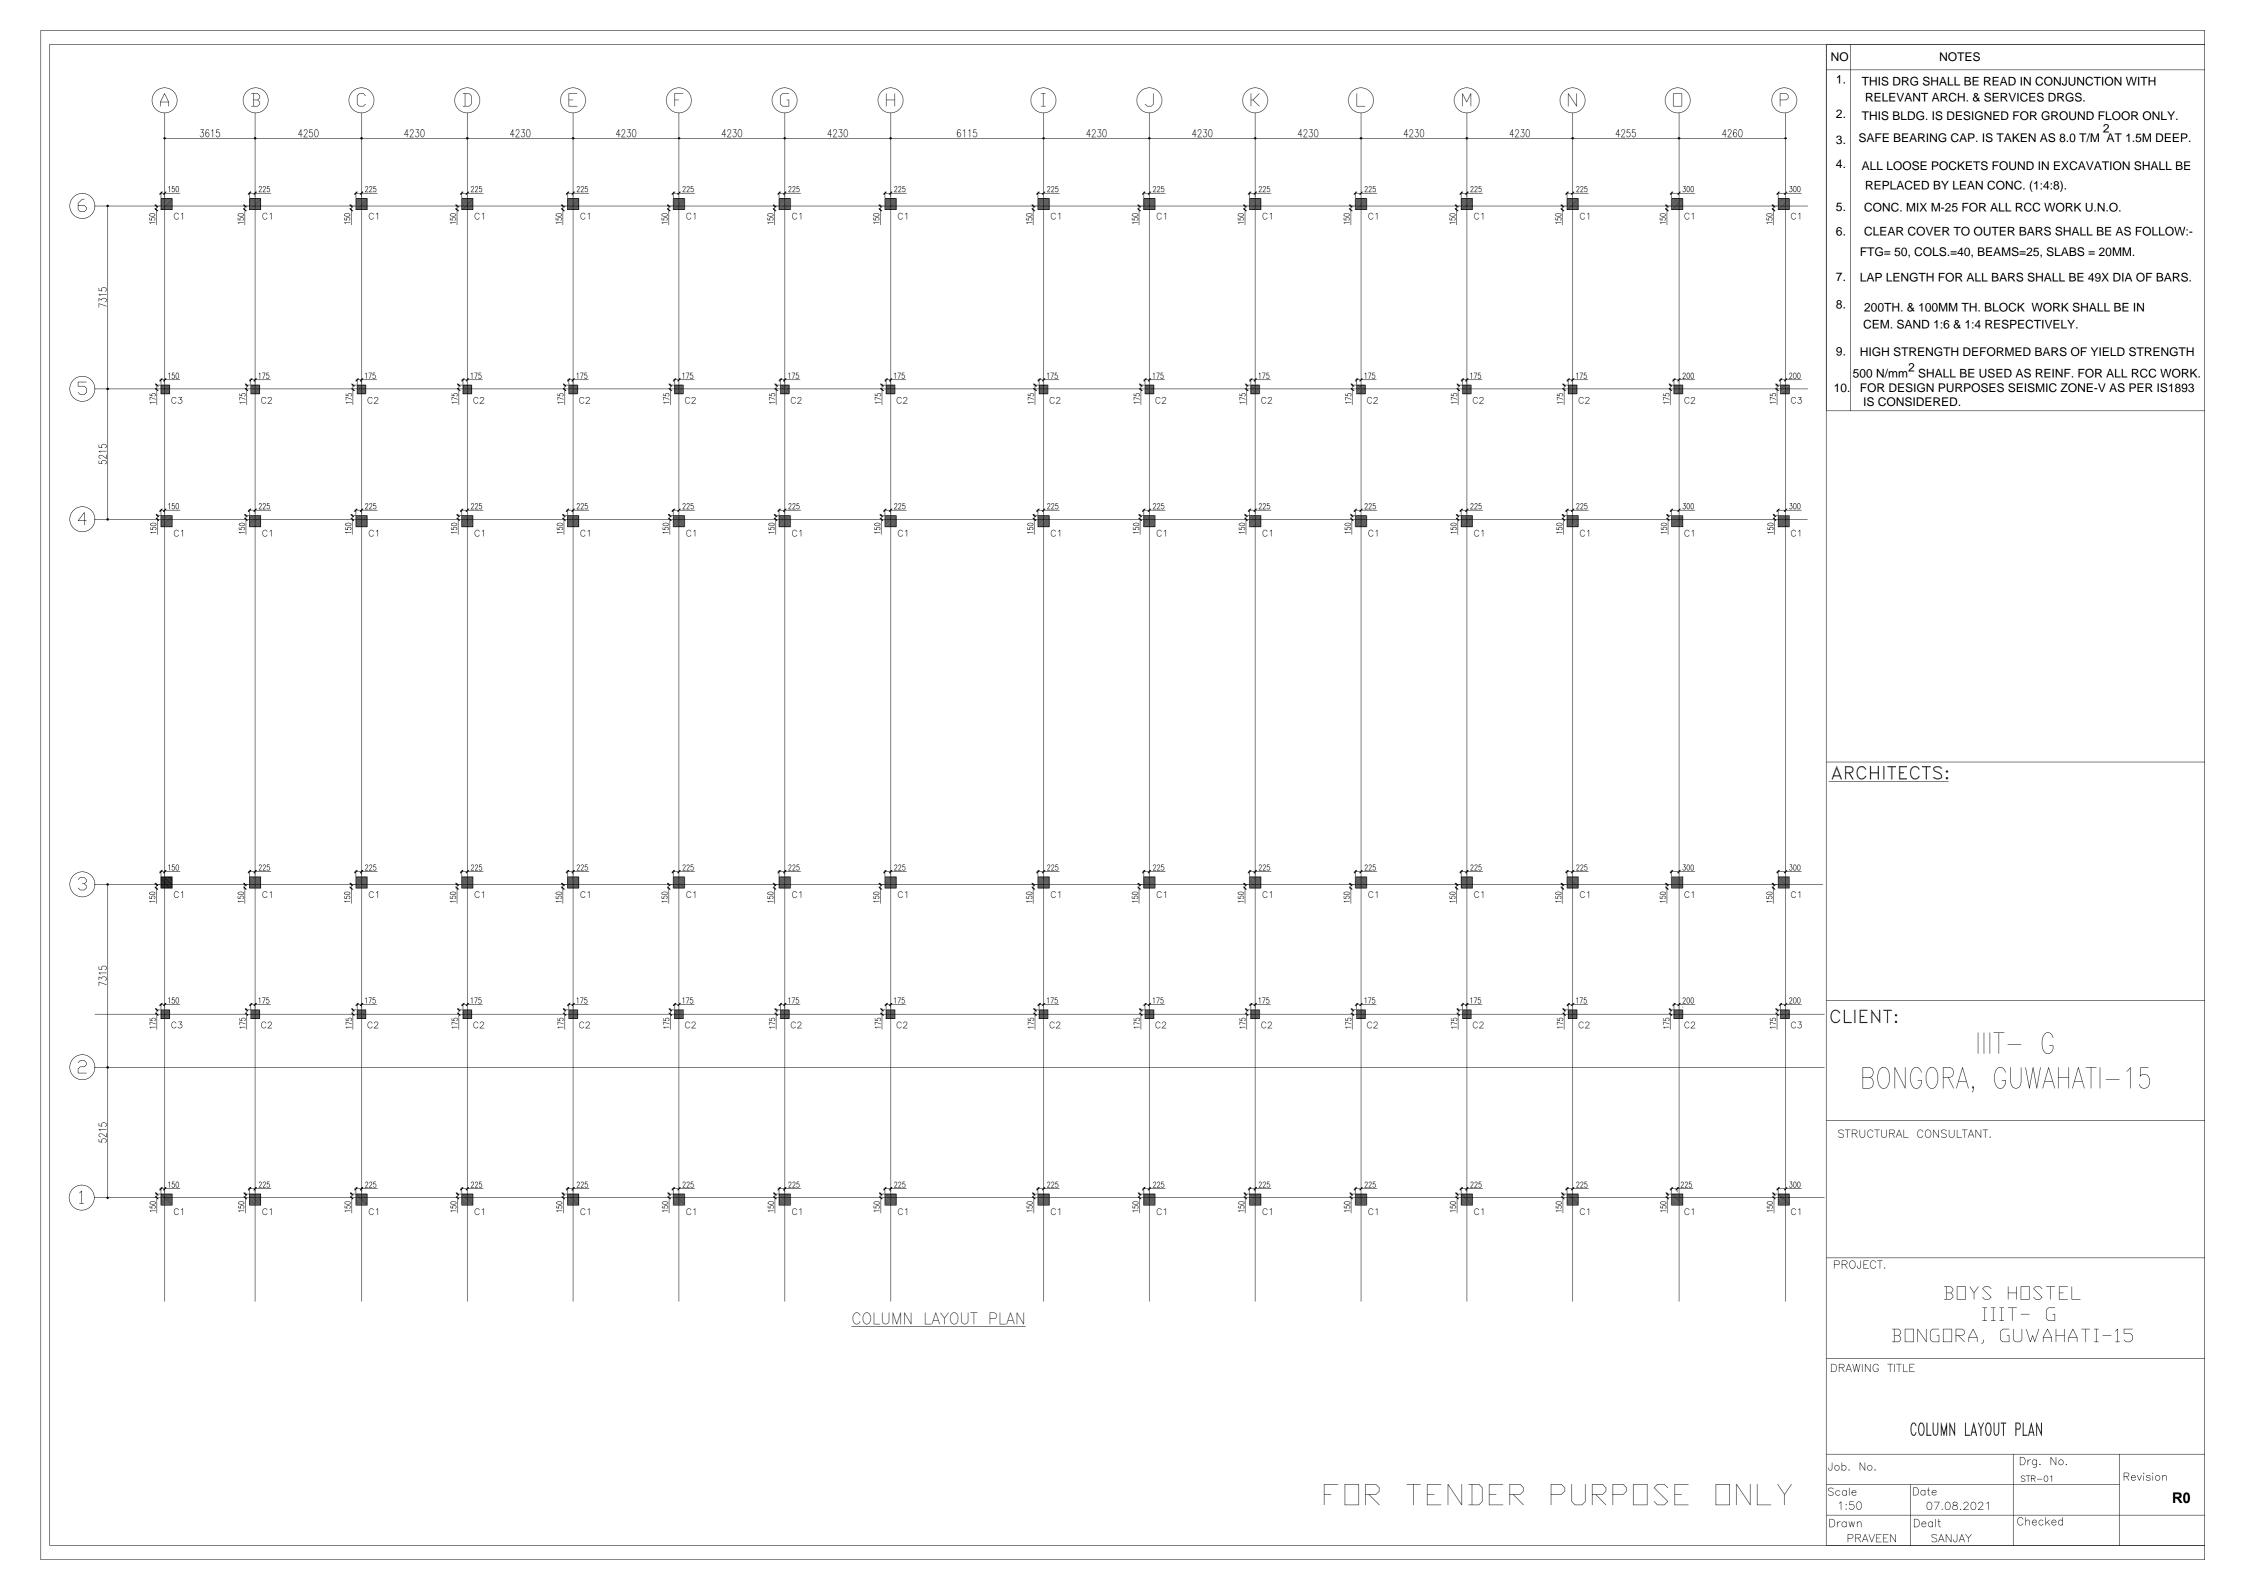

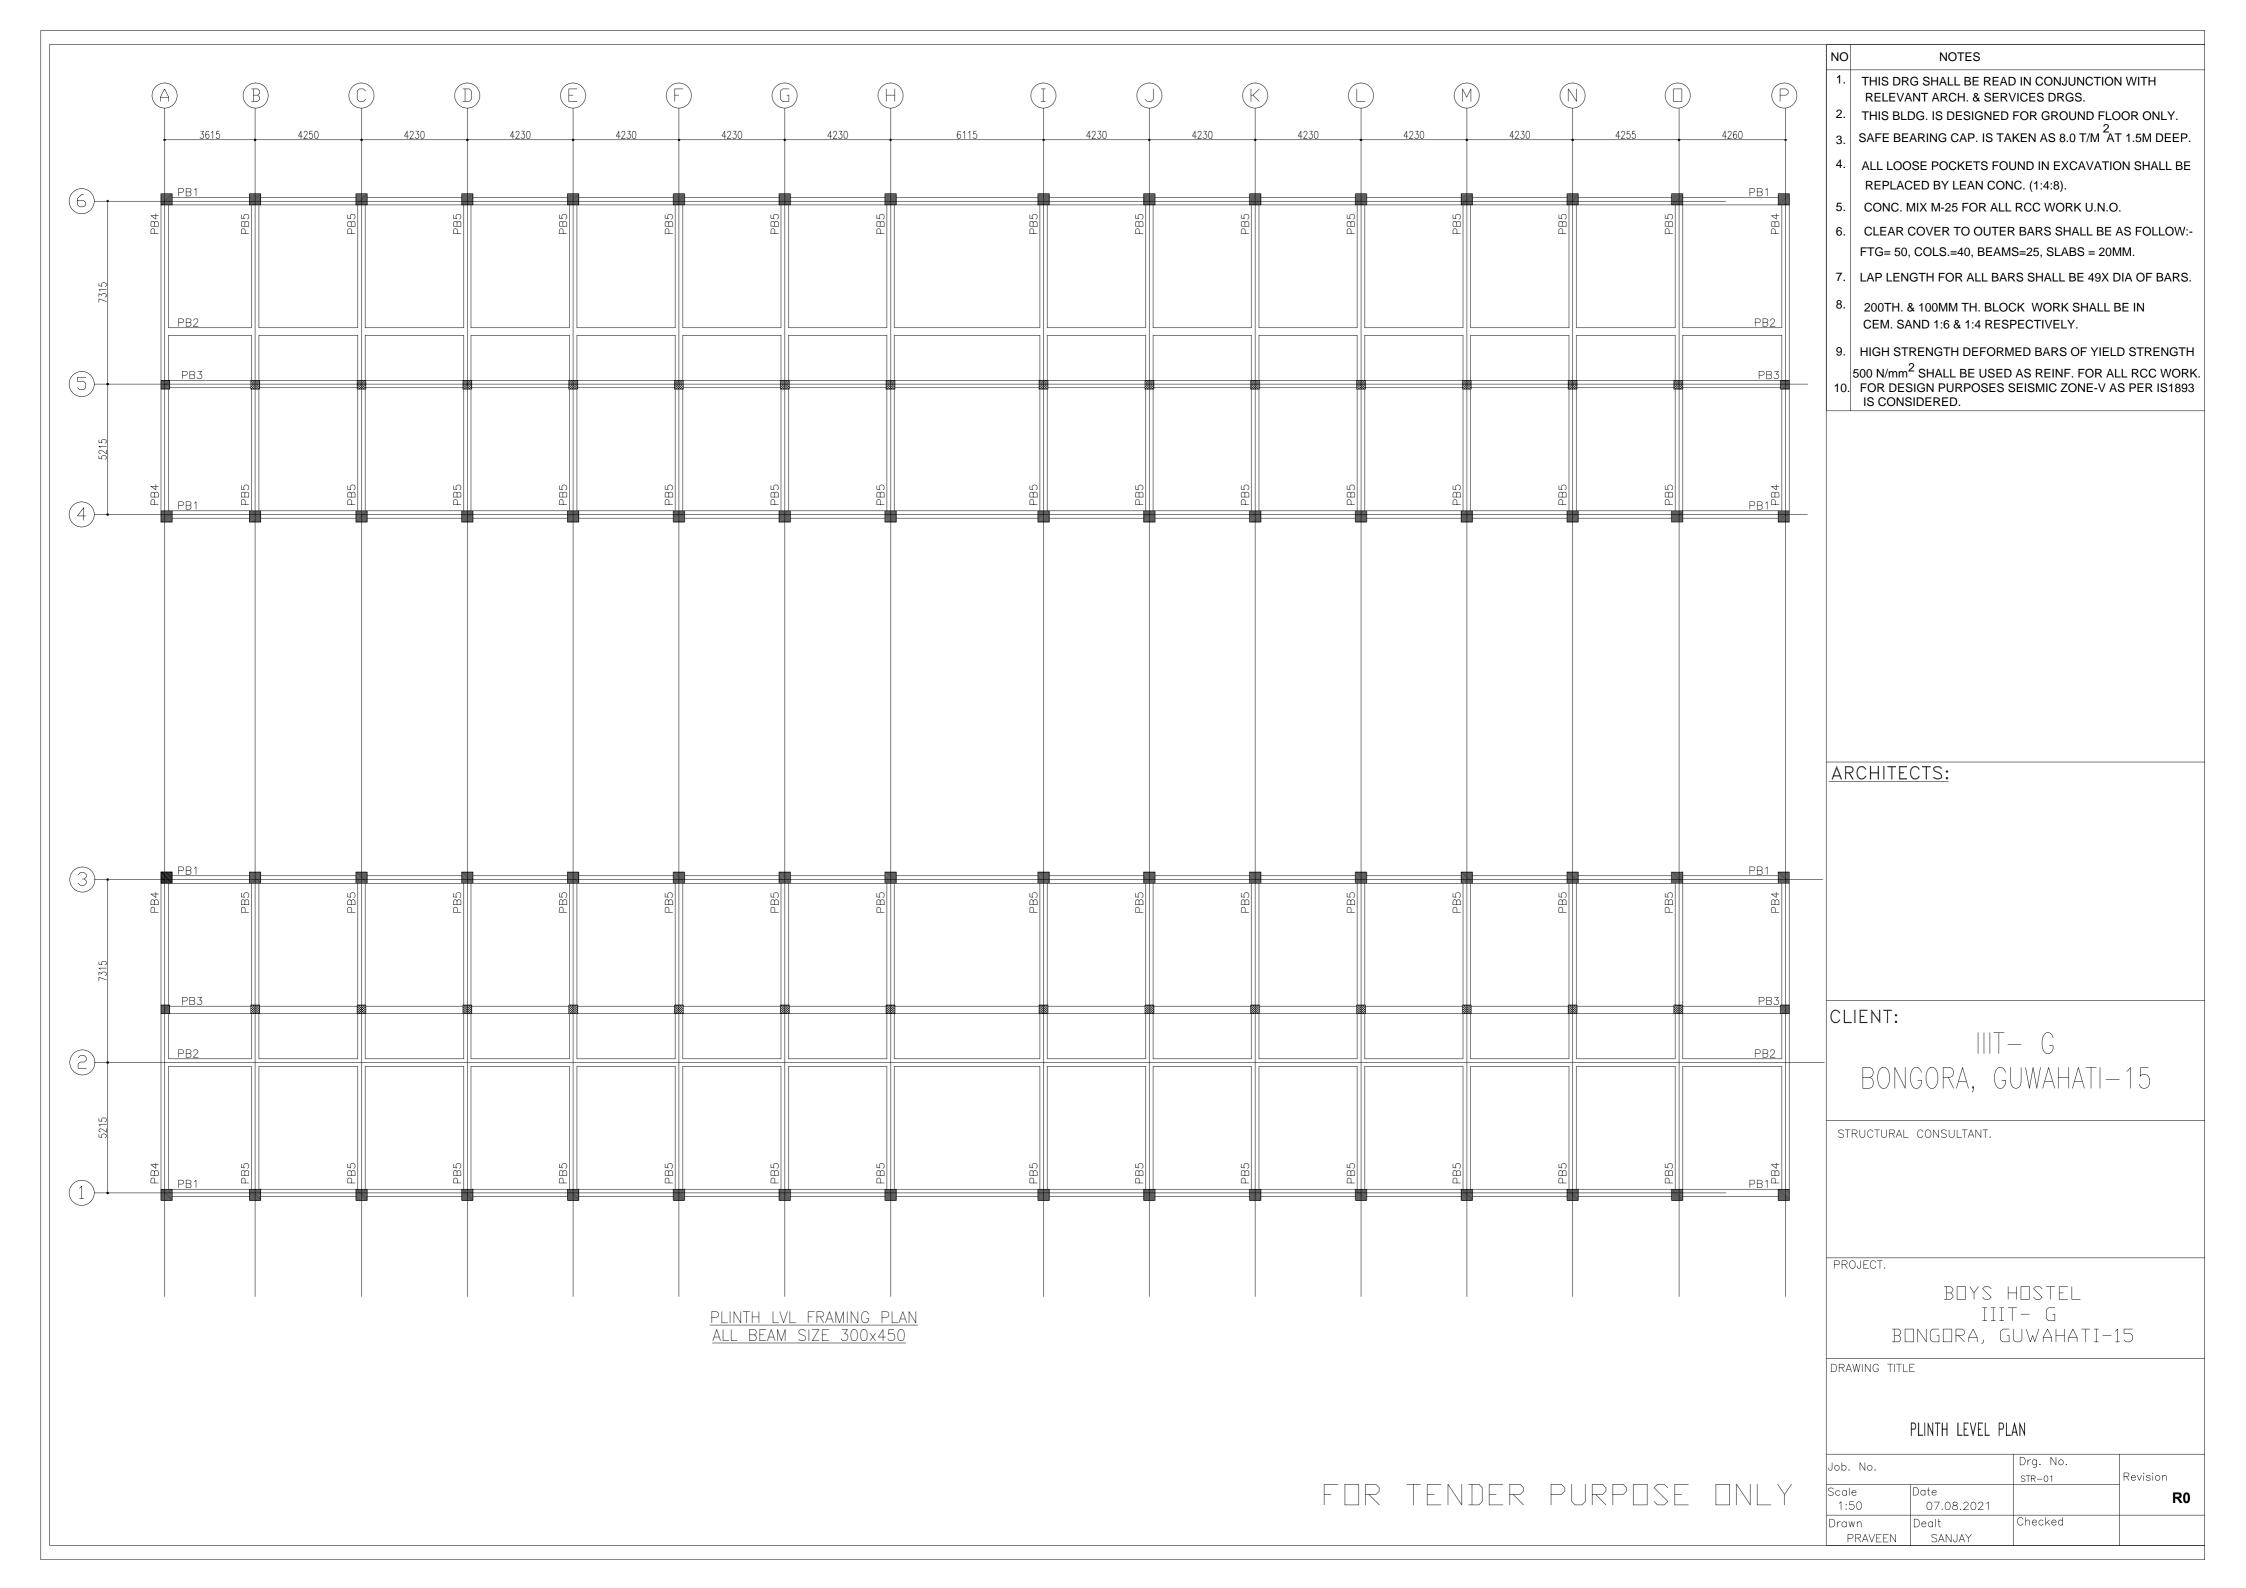

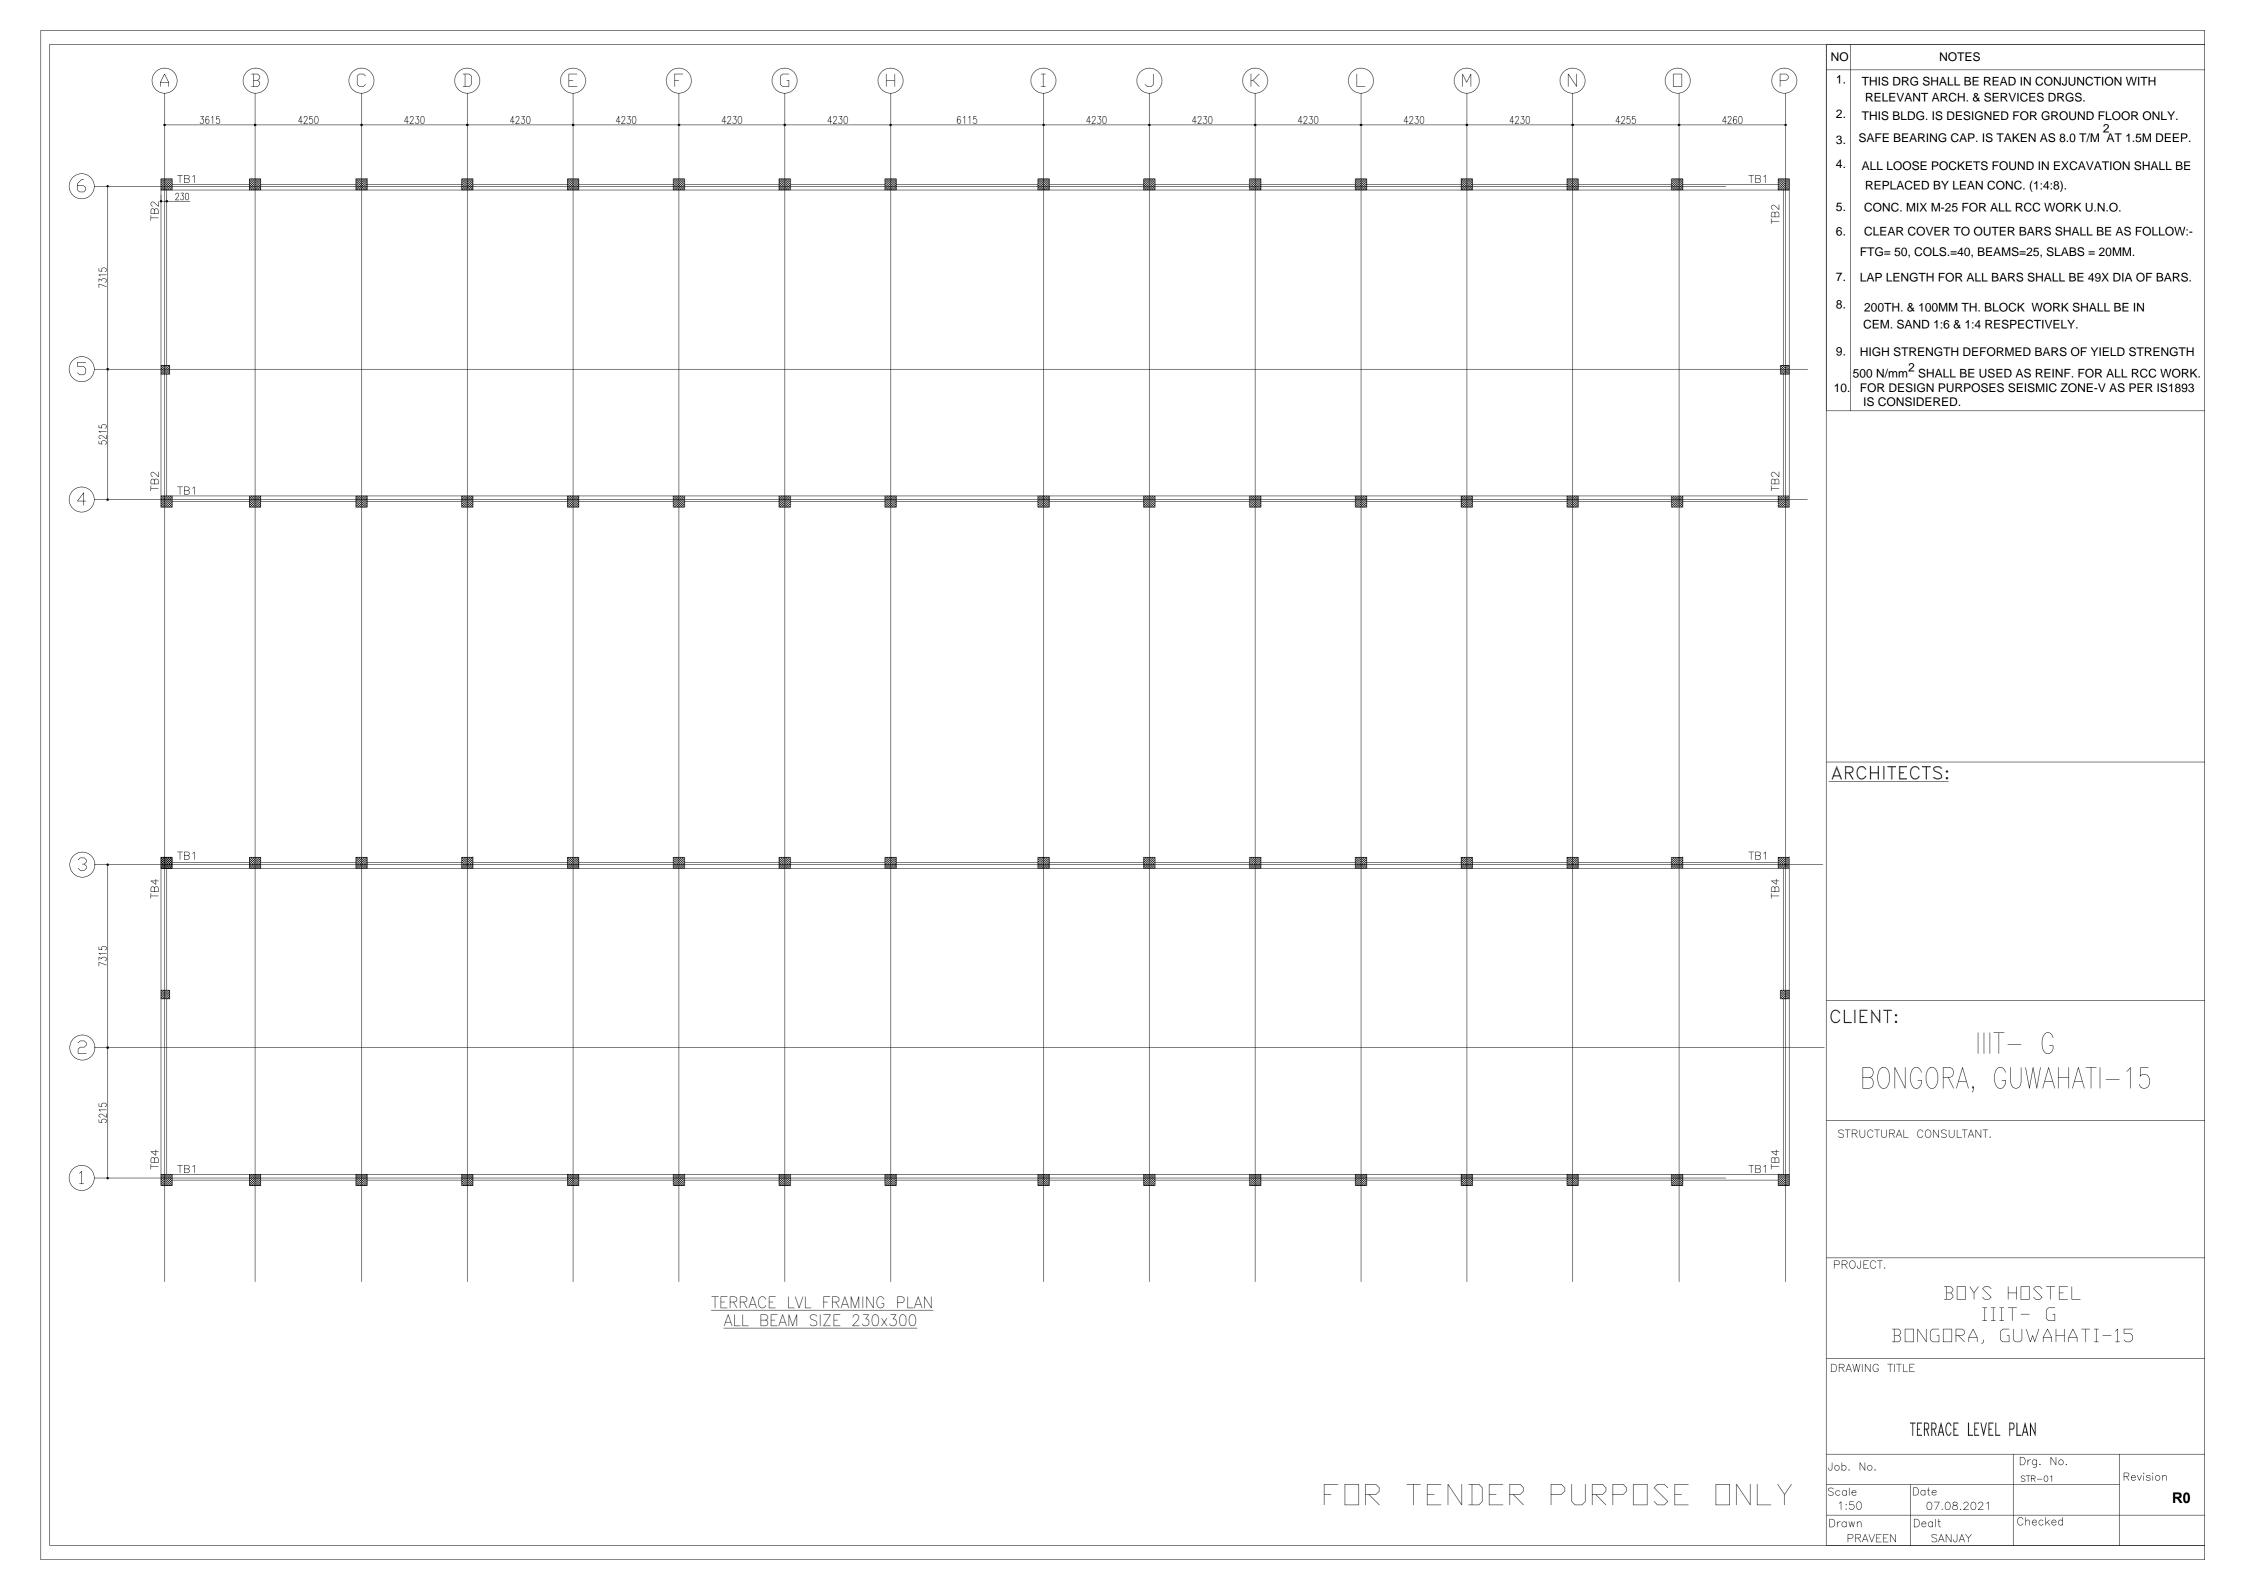

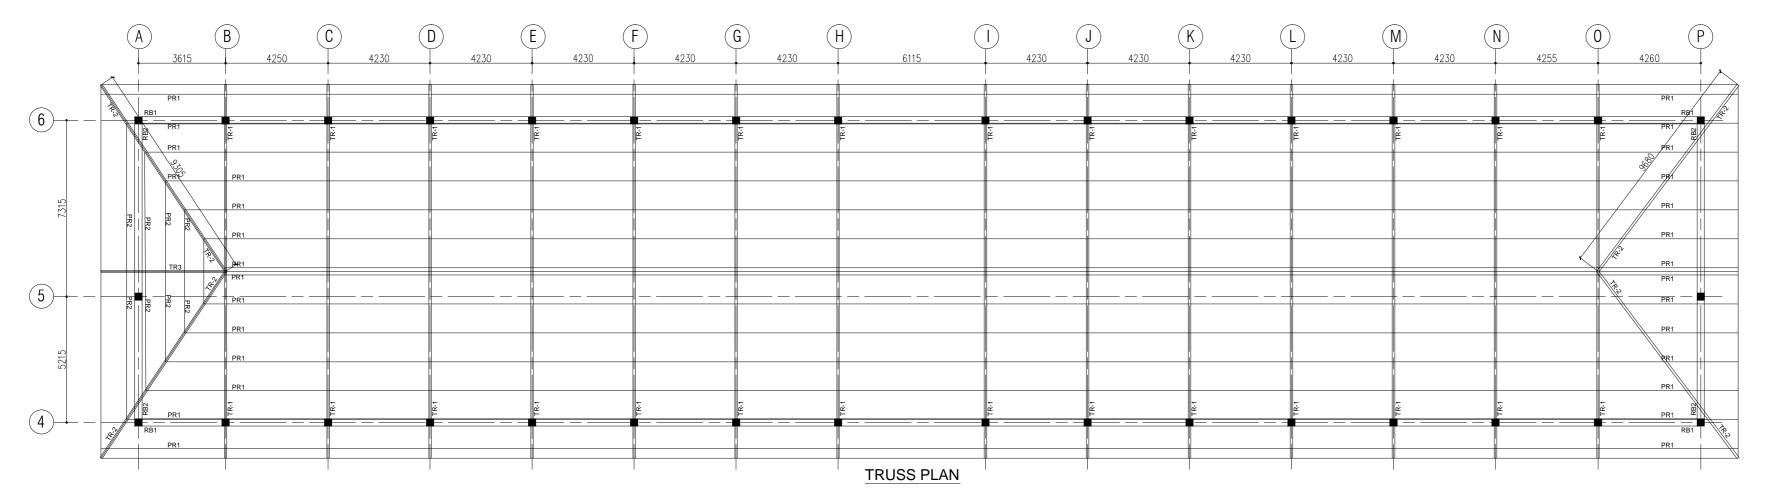

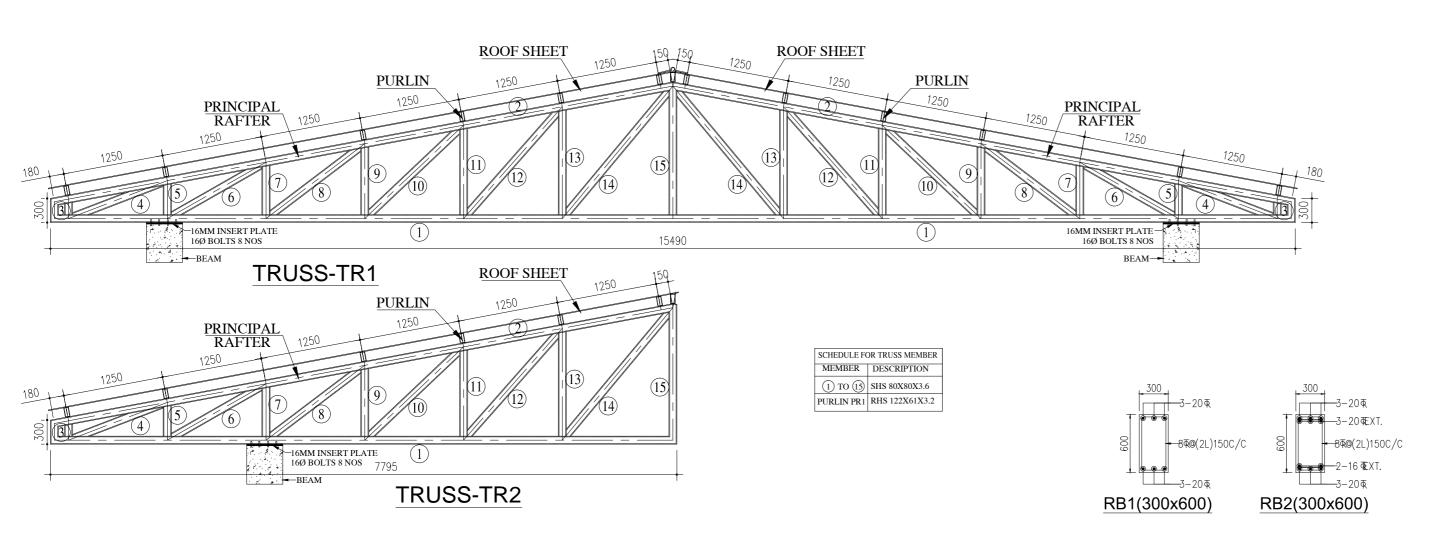

<u>NOTES</u>

- EXECUTING AGENCY SHOULD CHECK AND VERIFY ALL DIMENSIONS WITH RELEVANT ARCH DRAWINGS BEFORE EXECUTION OF THE WORKS.
- . ALL DIMENSIONS ARE GIVEN IN MILLIMETERS(MM), UNLESS NOTED OTHERWISE.
- 3. ONLY FIGURED DIMENSIONS SHALL BE FOLLOWED. 4. STEEL FOR STRUCTURAL SECTIONS EX- ANGLES, CHANNELS, BEARING PLATES,
- GUSSET PLATES & FLAT IRON SHALL BE HOT ROLLED HIGH TENSILE
- STRUCTURAL STEEL OF 350 MPa CONFORMING TO IS 2062-2011 GENERAL CONSTRUCTION IN STEEL WORK SHALL BE AS PER IS:800-2007
- 6. FABRICATION SHALL BE CARRIED OUT IN THE MANNER AS SPECIFIED IN IS:800-2007.
 7. ALL WELDING SHALL BE DONE BY METAL ARC PROCESS IN ACCORDANCE WITH
- IS: 816-1969. THE WELDS SHALL BE INSPECTED ACCORDING TO IS: 822-1970.
- 8. ALL WELDS SHALL BE FILLET WELD OF THICKNESS GIVEN BELOW
- FOR 6MM TH. MEMBERS 4.5 MM FOR 8MM TH. MEMBERS 6 MM FOR 10MM TH. MEMBERS 8 MM
- FOR 12MM TH. MEMBERS 10 MM

 9. PURLINS SHALL NOT BE SPLICED IN ANY SPAN.
- 10. AXIS OF WEB OF THE PURLIN SHALL BE PLACED AT 90° TO THE AXIS OF MAIN RAFTER OF THE TRUSS.
- 1. ALL GUSSET PLATES FOR TRUSS & BRACING SHALL BE 8 MM THK. 2. TRUSSES SHALL BE FABRICATED AFTER MAKING THEIR FULL SCALE CENTRE
- LINE LAYOUT PLAN IN GROUND/PLATFORM. 3. SHEET ROOFING OVER THE TRUSSES WILL BE OF 0.63 MM CORRUGATED GALVANISED IRON SHEETS OR PREPAINTED COLOUREED ENGINEERING
- METAL SHEETS LAID TO SLOPE SHOWN IN DRG.
- WIND TIE SHALL BE OF 40X6 MM FLAT IRON BOLTED & SCREWED AS SHOWN NEAR THE TOE & RIDGE.
- . DIMENSIONS & WEIGHTS OF HOT ROLLED STEELS SECTION SHALL BE AS PER IS: 808-2004.
- 5. HOLDING DOWN BOLTS WILL CONFORM TO IS 4000: 2003 & THESE WILL BE EMBEDDED IN EXACT POSITION IN RCC WORK WHILE CASTING THE CONCRETE.
- GENERAL REQUIREMENTS OF PAINTING THE STEEL WORK AS SPECIFIED IN CLAUSE 11 OF IS 800 SHALL BE MET. NUMBER OF COATS SHALL BE AS SPECIFIED IN CA.
- FOR SITE ERRECTION OF TRUSSES & PURLINS, REQUIREMENTS LAID DOWN
- IN CLAUSE 11.9 OF IS 800:2007 SHALL BE MET.

 18. ANGLE OF MIN.15 SHALL BE MAINTAINED B/W LONGITUDINAL AXIS OF TRUSS MEMBERS & EDGE LINE OF GUSSET PLATES IN ALL CONNECTIONS.
- . TWO NO'S WIND TIES EACH OF FLAT IRON 40X6MM WILL BE PROVIDED IN EACH SIDE OF SLOPING ROOF.ONE OF THE WIND TIE WILL BE NEAR EAVES END & OTHER NEAR THE RIDGE AS INDICATED IN DETAILS.
- . JOINTING DETAILS SHOWN ARE TYPICAL & THESE WILL BE ADOPTED FOR OTHER
- SIMILAR SITUATIONS ALSO.
- ALL CLEATS, BASE PLATES, INSERT PLATES AND OTHER SIMILAR FITMENTS WILL BE WELDED ALL AROUND TO FULL LENGTH.

s.no.	date	description		

REVISIONS

CONSTRUCTION AGENCY

ARCHITECT

STRUCTURAL CONSULTANTS:

PROJECT

IIIT- G BONGORA, GUWAHATI-15

Drawing Title

TRUSS PLAN & DETAILS BOYS HOSTEL

		Drg. No.		Revision
Job. No.				
Scale	Date			R0
1:100,50	29.08.21	STR/S-001A		
NARESH Drawn	SANJAY Dealt	SANJAY Checked	AP	PROVED

